# JUNIPER AND IVY OUTDOOR DINING AREA



# CAL-GREEN NOTES

- AUTOMATIC IRRIGATION SYSTEMS CONTROLLERS INSTALLED AT THE TIME OF FINAL INSPECTION SHALL BE WEATHER BASED JOINTS AND OPENINGS, ANNULAR SPACES AROUND PIPES, ELECTRIC CABLES, CONDUITS, OR OTHER OPENINGS IN PLATES AT EXTERIOR WALLS SHALL BE PROTECTED AGAINST THE PASSAGE OF RODENTS BY CLOSING SUCH OPENINGS WITH CEMENT MORTAR, CONCRETE MASONRY OR SIMILAR METHOD ACCEPTABLE TO THE ENFORCING AGENCY.
- MAINTENANCE MANUAL
- ALL DUCT AND OTHER RELATED AIR DISTRIBUTION COMPONENT OPENINGS SHALL BE COVERED DURING WITH TAPE.
- PLASTIC OR SHEET METAL UNTIL THE FINAL STARTUP OF THE HEATING, COOLING AND VENTILATION EQUIPMENT.
- ADHESIVES, SEALANTS AND CAULKS SHALL BE COMPLIANT WITH VOC AND OTHER TOXIC COMPOUND LIMITS. PAINTS, STAINS, COATINGS, ADHESIVES, SEALANTS AND CAULKS SHALL COMPLY WITH THE VOLATILE ORGANIC COMPOUND (VOC) LIMITS LISTED IN 2016 CALGREEN SECTION 4.504.2.1.
- AEROSOL PAINTS AND COATINGS SHALL BE COMPLIANT WITH PRODUCT WEIGHTED MIR LIMITS FOR VOC AND OTHER
- DOCUMENTATION SHALL BE PROVIDED TO VERIFY THAT COMPLIANT VOC LIMIT FINISH MATERIALS HAVE BEEN USED, A LETTER FROM THE CONTRACTOR AND OR THE BUILDING OWNER CERTIFYING WHAT MATERIAL HAS BEEN USED AND ITS COMPLIANCE WITH THE CODE MUST BE SUBMITTED TO THE BUILDING INSPECTOR.
- CARPET AND CARPET SYSTEMS SHALL BE COMPLIANT WITH VOC LIMITS. A LETTER FROM THE CONTRACTOR AND OR THE BUILDING OWNER CERTIFYING WHAT MATERIAL HAS BEEN USED AND ITS COMPLIANCE WITH THE CODE MUST BE SUBMITTED TO THE BUILDING INSPECTOR.
- 80 PERCENT OF THE FLOOR AREA RECEIVING RESILIENT FLOORING SHALL COMPLY WITH ONE OR MORE OF THE FOLLOWING: 1- VOC EMISSION LIMITS DEFINED IN THE COLLABORATIVE FOR HIGH PERFORMANCE SCHOOLS (CHPS) HIGH PERFORMANCE PRODUCTS DATABASE. 2- PRODUCTS COMPLIANT WITH CHPS CRITERIA CERTIFIED UNDER THE GREENGUARD CHILDREN AND SCHOOL PROGRAM. 3- CERTIFICATION UNDER THE RESILIENT FLOOR COVERING INSTITUTE (RFCI) FLOORSCORE PROGRAM. 4- MEET THE CALIFORNIA DEPARTMENT OF PUBLIC HEATLTH, STANDARD METHOD FOR THE TESTING AND EVALUATION OF VOLATILE ORGANIC CHEMICAL EMISSIONS FROM INDOOR SOURCES USING ENVIRONMENTAL CHAMBERS. VERSION 1.1, FEB. 2010 (ALSO KNOWN AS SPECIFICATION 01350).
- NEW HARDWOOD PLYWOOD, PARTICLE BOARD, AND MEDIUM DENSITY FIBERBOARD (MDF) COMPOSITE WOOD PRODUCT USE IN THE BUILDING SHALL MEET THE FORMALDEHYDE LIMITS LISTED IN 2016 CALGREEN TABLE 4.504.5.
- BUILDING MATERIALS WITH VISIBLE SIGNS OF WATER DAMAGE SHALL NOT BE INSTALLED. WALLS AND FLOOR FRAMING SHALL NOT BE ENCLOSED WHEN FRAMING MEMBER EXCEED 19% MOISTURE CONTENT.
- MOISTURE CONTENT OF BUILDING MATERIALS USED IN WALL AND FLOOR FRAMING IS CHECKED BEFORE ENCLOSURE. MOISTURE CONTENT SHALL BE VERIFIED BE EITHER A PROBE TYPE OR CONTACT TYPE MOISTURE METER. A CERTIFICATE OF COMPLIANCE INDICATING DATE OF TEST, LOCATION AND RESULTS ISSUED BY THE FRAMER SUBCONTRACTOR OR
- GENERAL CONTRACTOR MUST BE SUBMITTED TO THE BUILDING INSPECTOR. EXHAUST FANS WHICH TERMINATE OUTSIDE THE BUILDING ARE PROVIDED IN EVERY BATHROOM THAT CONTAINS A SHOWER OR TUB. UNLESS FUNCTIONING AS A COMPONENT OF A WHOLE HOUSE VENTILATION SYSTEM, FANS MUST BE CONTROLLED BY A HUMIDISTAT WHICH CAN BE ADJUSTED BETWEEN 50-80 PERCENT.
- THE FORMALDEHYDE EMISSIONS VERIFICATION SHALL BE MADE AVAILABLE TO CITY STAFF UPON REQUEST.
- BUILDING MATERIALS WITH VISIBLE SIGNS OF WATER DAMAGE SHALL NOT BE INSTALLED. WALLS AND FLOORS FRAMING SHAL
- NOT BE ENCLOSED WHEN FRAMING MEMBERS EXCEED 19% MOISTURE CONTENT. OUTLET TO BE IN OPERATION AT A TIME. HANDHELD SHOWERS ARE CONSIDERED SHOWERHEADS.
- 29. ATTIC/UNDERFLOOR INSTALLATION MUST COMPLY WITH SECTIONS 904, 908, AND 909 OF CALIFORNIA MECHANICAL CODE 20. INTERIOR SPACES INTENDED FOR HUMAN OCCUPANCY SHALL BE PROVIDED WITH SPACE-HEATING SYSTEM CAPABLE OF
- MAINTAINING A MINIMUM INDOOR TEMP. OF 68 DEGREES F. (PER SECTION 1204.1 CBC). VAPOR RETARDER AND CAPILLARY BREAK IS INSTALLED AT SLAB ON GRADE FOUNDATIONS. SEE S1 FOR SPECIFICATIONS.
- A PLUMBING FIXTURE CERTIFICATION MUST BE COMPLETED AND SIGNED BY EITHER A LICENSED GENERAL CONTRACTOR, A PLUMBING SUBCONTRACTOR, OR THE BUILDING OWNER CERTIFYING THE FLOW RATE OF THE FIXTURES INSTALLED. A COPY OF THE CERTIFICATION CAN BE OBTAINED FROM THE DEVELOPMENT SERVICES DEPARTMENT.
- NEW RESIDENTIAL DEVELOPMENTS WITH A LANDSCAPE AREA OVER  $500\,\mathrm{SQ}$ . FT. SHALL COMPLY WITH ONE OF THE FOLLOWING - LOCAL WATER EFFICIENT LANDSCAPE ORDINANCE OR CURRENT CALIFORNIA DEVELOPMENT OF WATER RESOURCES MODEL WATER EFFICIENT LANDSCAPE ORDINANCE (MWELO).
- LANDSCAPE AREAS LESS THAN 2500 SQ. FT. MAY COMPLY WITH MWELO'S APPENDIX D PRESCRIPTIVE COMPLIANCE OPTION. THE VOC CONTENT VERIFICATION SHALL BE MADE AVAILABLE TO THE CITY STAFF UPON REQUEST.
- ALL NEW AND CARPET CUSHIONS INSTALLED IN THE BUILDING INTERIOR SHALL MEET THE TESTING PRODUCT REQUIREMENTS OF ONE OF THE FOLLOWING:
  - CARPET AND RUG INSTITUTES GREEN LEVEL PLUS PROGRAM
- CALIFORNIA DEPARTMENT OF PUBLIC HEALTH SPECIFICATIONS 01350
- NSF/ANSI 140 AT THE FOLD LEVEL
- SCIENTIFIC CERTIFICATION SYSTEMS INDOOR ADVANTAGE TM GOLD NEWLY INSTALLED BATHROOM EXHAUST FANS SHALL BE ENERGY START COMPLIANT AND DE DUCTED TO TERMINATE OUTSIDE OF THE BUILDING. UNLESS FUNCTIONING AS A COMPONENT OF A WHOLE HOUSE VENTILATION SYSTEM. FANS MUST BE CONTROLLED BY A HUMIDSTAT WHICH CAN ADJUST BETWEEN 50 AND 80 PERCENT.

# ABBREVIATIONS

**SOLID CORE** 

SCREEN

**SCHEDULE** 

**SECTION** 

**SPECIFICATIONS** 

**SQUARE FEET** 

**STORAGE** 

THRESHOLD

**THICKNESS** 

**VERIFY IN FIELD** 

VERTICAL

VESTIBULE

**UNLESS NOTED OTHERWISE** 

VINYL COMPOSITION TILE

**TYPICAL** 

URINAL

**SHEET** 

SCR.

SEC.

STL.

UNO.

UR.

VCT.

VERT.

VEST.

AC.	ACOUSTIC	HC.	HOLLOW CORE
ACT.	ACTUAL	HDW.	HARDWARE
AL.	ALUMINUM	НМ.	HOLLOW METAL
ARCH.	ARCHITECTURAL	HORT.	HORIZONTALUR.URINAL
AVG.	AVERAGE	HT.	HEIGHT
BLK.	BLOCK	HW.	HOT WATER
BPL.	BEARING PLATE	I.D.	INSIDE DIMENSION
BR.	BRICK, BEDROOM	INTR.DSGNR.	INTERIOR DESIGNER
CPT.	CARPET	INSUL.	INSULATION
CMU.	CONC MSNRY UNIT	INT.	INTERIOR
CFM.	CFM.	KIT.	KITCHEN
C.I.	CASTIRON	LAM.	LAMINATED
CL.	CENTERLINE	LAV.	LAVATORY
CLG.	CEILING	LR.	LIVING ROOM
CLO.	CLOSET	LT.LIGHT	LT.LIGHT
CONST.	CONSTRUCTION	MAR.	MARBLE
CONC.	CONCRETE	MATL.	MATERIAL
CONT.	CONTINUOUS	MAX.	MAXIMUM
CT.	CERAMIC TILE	MET.	METAL
C.TO C.	CNTR TO CNTR	MIN.	MINIMUM
CW.	COLD WATER	M.O.	MASONRY OPENING
DB.	DOUBLE	MULL.	MULLION
DTL.	DETAIL	N.	NEW
DIA.	DIAMETER	N.A.	NOT APPLICABLE
DIM.	DIMENSION	NAT.	NATURAL
DN.	DOWN	NIC.	NOT IN CONTRACT
DO.	DITTO	NO.,#	NUMBER
DR.	DOOR	NOM.	NOMINAL
DS.	DOWN SPOUT	NTS.	NOT TO SCALE
DWG.	DRAWING	O.C.	ON CENTER
E.	EXISTING	O.D.	OUTSIDE DIMENSION
EA.	EACH	P.	PAINT
ELEV.	ELEVATIONS	PL.	PLASTER, PLATE
EST.	ESTIMATED	PLYWD.	PLYWOOD
E.W.	EACH WAY	POL.	POLISHED
EXIST.	EXISTING	PSI.	LBS. PER SQR INCH
EXT.	EXTERIOR	PSF.	LBS PER SQR FOOT
F.F.	FINISH FLOOR	R.	RISER, RANGE, RADIUS
FL.	FLOOR	RCP.	REFLECTED CEILING PLAN
FLASH.	FLASHING	REBAR.	REINFORCING BAR
F.O.	FINISH OPENING	REFR.	REFRIGERATOR
GA.	GAUGE	REF.	REFERENCE
GALV.	GALVANIZED	REV.	REVISION
G.I.	GALVANIZED IRON	RM., RMS.	ROOM, ROOMS
GL.	GLASS	R.O.	ROUGH OPENING
GYP. BD.	GYPSUM BOARD	S.A.	SUPPLY AIR
НВ.	HOSE BIBB	S.& V.	STAIN AND VARNISH

# SCOPE OF WORK

THE WORK DESCRIBED IN THIS CONSTRUCTION DOCUMENT SET, SETS FOR THE SPECIFIC DIRECTIVES PRESCRIBING ACTIVITIES AS THEY RELATE TO THE FOLLOWING OBJECTIVES FOR THIS PROJECT.

- NEIGHBORHOOD USE PERMIT TO CREATE THE FOLLOWING DESIGNATION OF EXISTING OUTDOOR AREA @ NORTH SIDE OF EXISTING RESTAURANT FOR USE AS OUTDOOR DINING AREA. SCOPE OF PROJECT DOES NOT PROPOSE ANY MODIFICATIONS OR ALTERATIONS TO THE EXISTING RESTAURANT'S INTERIOR, EGRESS, OCCUPANT LOAD (EGRESS) OR OTHER FACILITIES.
- TOTAL AREA OF NEW OUTDOOR DINING AREA = 1,290 SQ. FT.


## MISC. NOTES

THE STRUCTURE WILL BE LOCATED ENTIRELY ON NATIVE/ UNDISTURBED SOIL



- GENERAL CONTRACTOR TO FIELD VERIFY ALL DIMENSIONS. ANY
- GENERAL CONTRACTOR TO COORDINATE WITH SURVEYOR TO PROVIDE CITY FIELD INSPECTION SERVICES OVERALL HEIGHT HEIGHT WITH SURVEYOR DURING FRAMING OPERATIONS TO ENSURE COMPLIANCE WITH HEIGHT REQ'S.
- GENERAL CONTRACTOR TO COORDINATE ALL R.O.W. WORK W/ NOMINATED CLASS 'A' CONTRACTOR.
- GENERAL CONTRACTOR TO COORDINATE ANY FIRE SPRINKLER CONTRACTOR WORK
- GENERAL CONTRACTOR TO BE RESPONSIBLE FOR THE INSTALLATION AND MAINTENANCE OF ANY/ALL CONSTRUCTION BMP'S (SEE BMP PLAN THIS SET IF ANY)

# VICINITY MAP

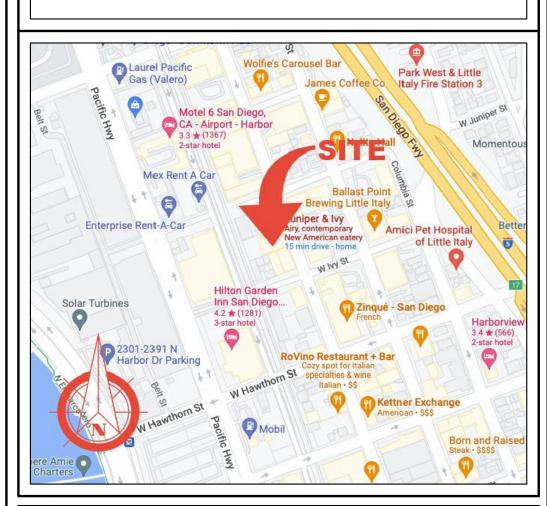

# CODES

THIS BUILDING SHALL COMPLY WITH THE FOLLOWING:

CITY OF SAN DIEGO CURRENT PLANNING, ENGINEERING, AND BUILDING DEPARTMENT REGULATIONS.

2022 ed. OF THE CALIFORNIA RESIDENTIAL CODE 2022 ed. OF THE CALIFORNIA MECHANICAL CODE 2022 ed. OF THE CALIFORNIA ELECTRICAL CODE 2022 ed. OF THE CALIFORNIA PLUMBING CODE

2022 ed. OF THE CALIFORNIA FIRE CODE 2022 ed. OF THE CALIFORNIA GREEN BUILDING STANDARDS 2022 ed. OF THE CALIFORNIA TITLE 24 COMPLIANCE

OCCUPATIONAL SAFETY AND HEALTH STANDARDS, CURRENT EDITION

# SHEET INDEX

SHEET#	SHEET NAME	SHEET TITLE
1	TS	TITLE SHEET
2	A0.0	SITE PLAN
3	A1.0	EXISTING RESTAURANT1ST FLOOR PLAN - INFO ONLY
4	A1.0X	E. RESTAURANT1ST FLOOR PLAN EGRESS PLAN INFO ONLY - NO PROPOSED CHANGE
5	A1.1	EXISTING RESTAURANT2ND FLOOR PLAN - INFO ONLY
6	A1.1X	E. RESTAURANT2ND FLOOR PLAN EGRESS PLAN INFO ONLY - NO PROPOSED CHANGE
7	A2.0	NEW OUTDOOR DINING PLAN / EGRESS PLAN

# PROJECT DATA

#### **OWNER INFORMATION**

#### PARCEL INFORMATION

SITE ADDRESS 2228 KETTNER BLVD. SAN DIEGO, CA 92101 533-112-10-00 LOT AREA 8,830 SQ.FT.

**SUBDIVISION NAME** S D LAND & TOWN CO ADD

BLK 64\*BLK 10\*PAR C PER DOC15-0369392 IN\

#### **ZONING INFORMATION**

**ZONE** CCPD-MC **OVERLAYS** 

TRANSIT AREA, TRANSPORTATION PRIORITY, AIRPORT INFLUENCE,

GEO HAZ.

#### EXISTING RESTAURANT STRUCTURE INFORMATION(NO PROPOSED MODS.)

CONSTRUCTION TYPE V-B FIRE SPRINKLERS OCCUPANCY A2 - RESTAURANT STORIES 2-STORIES 1ST FLOOR AREA 6,625 SQ.FT. 2ND FLOOR AREA 1,244 SQ.FT.

#### PROPOSED AREA OF OUTDOOR DINING AREA FOR NUP

CONSTRUCTION TYPE NO STRUCTURE PROPOSED. FIRE SPRINKLERS OCCUPANCY

STORIES N. OUTDOOR DINING 1,290 SQ.FT.

OWNER NAME	MICHAEL RONSEN - JUNIPER HOSPITALITY, LLO
MAIN ADDRESS	2228 KETTNER BLVD.
	SAN DIEGO, CA 92101

AIRPORT APPROACH, COMPLETE COMMUNITIES TIER 1,

E. OUTDOOR PATIO 626 SQ.FT.

> A2 - RESTAURANT 0-STORIES. NO STRUCTURE PROPOSED

BLDG. DEPT. PLN. CHK

PQ DESIGN

STUDIOINC

SAN DIEGO, CALIFORNIA 92109


RIGHTS RESERVED. THESE PLANS MAY NOT BE REPRODUCED WITHOUT TH PRIOR WRITTEN CONSENT OF PQ

DOCUMENT(S) ARE SOLELY MAINTAINED BY PQ DESIGN STUDIO INC

DRAWN BY

DATE 02-10-2023

SCALE

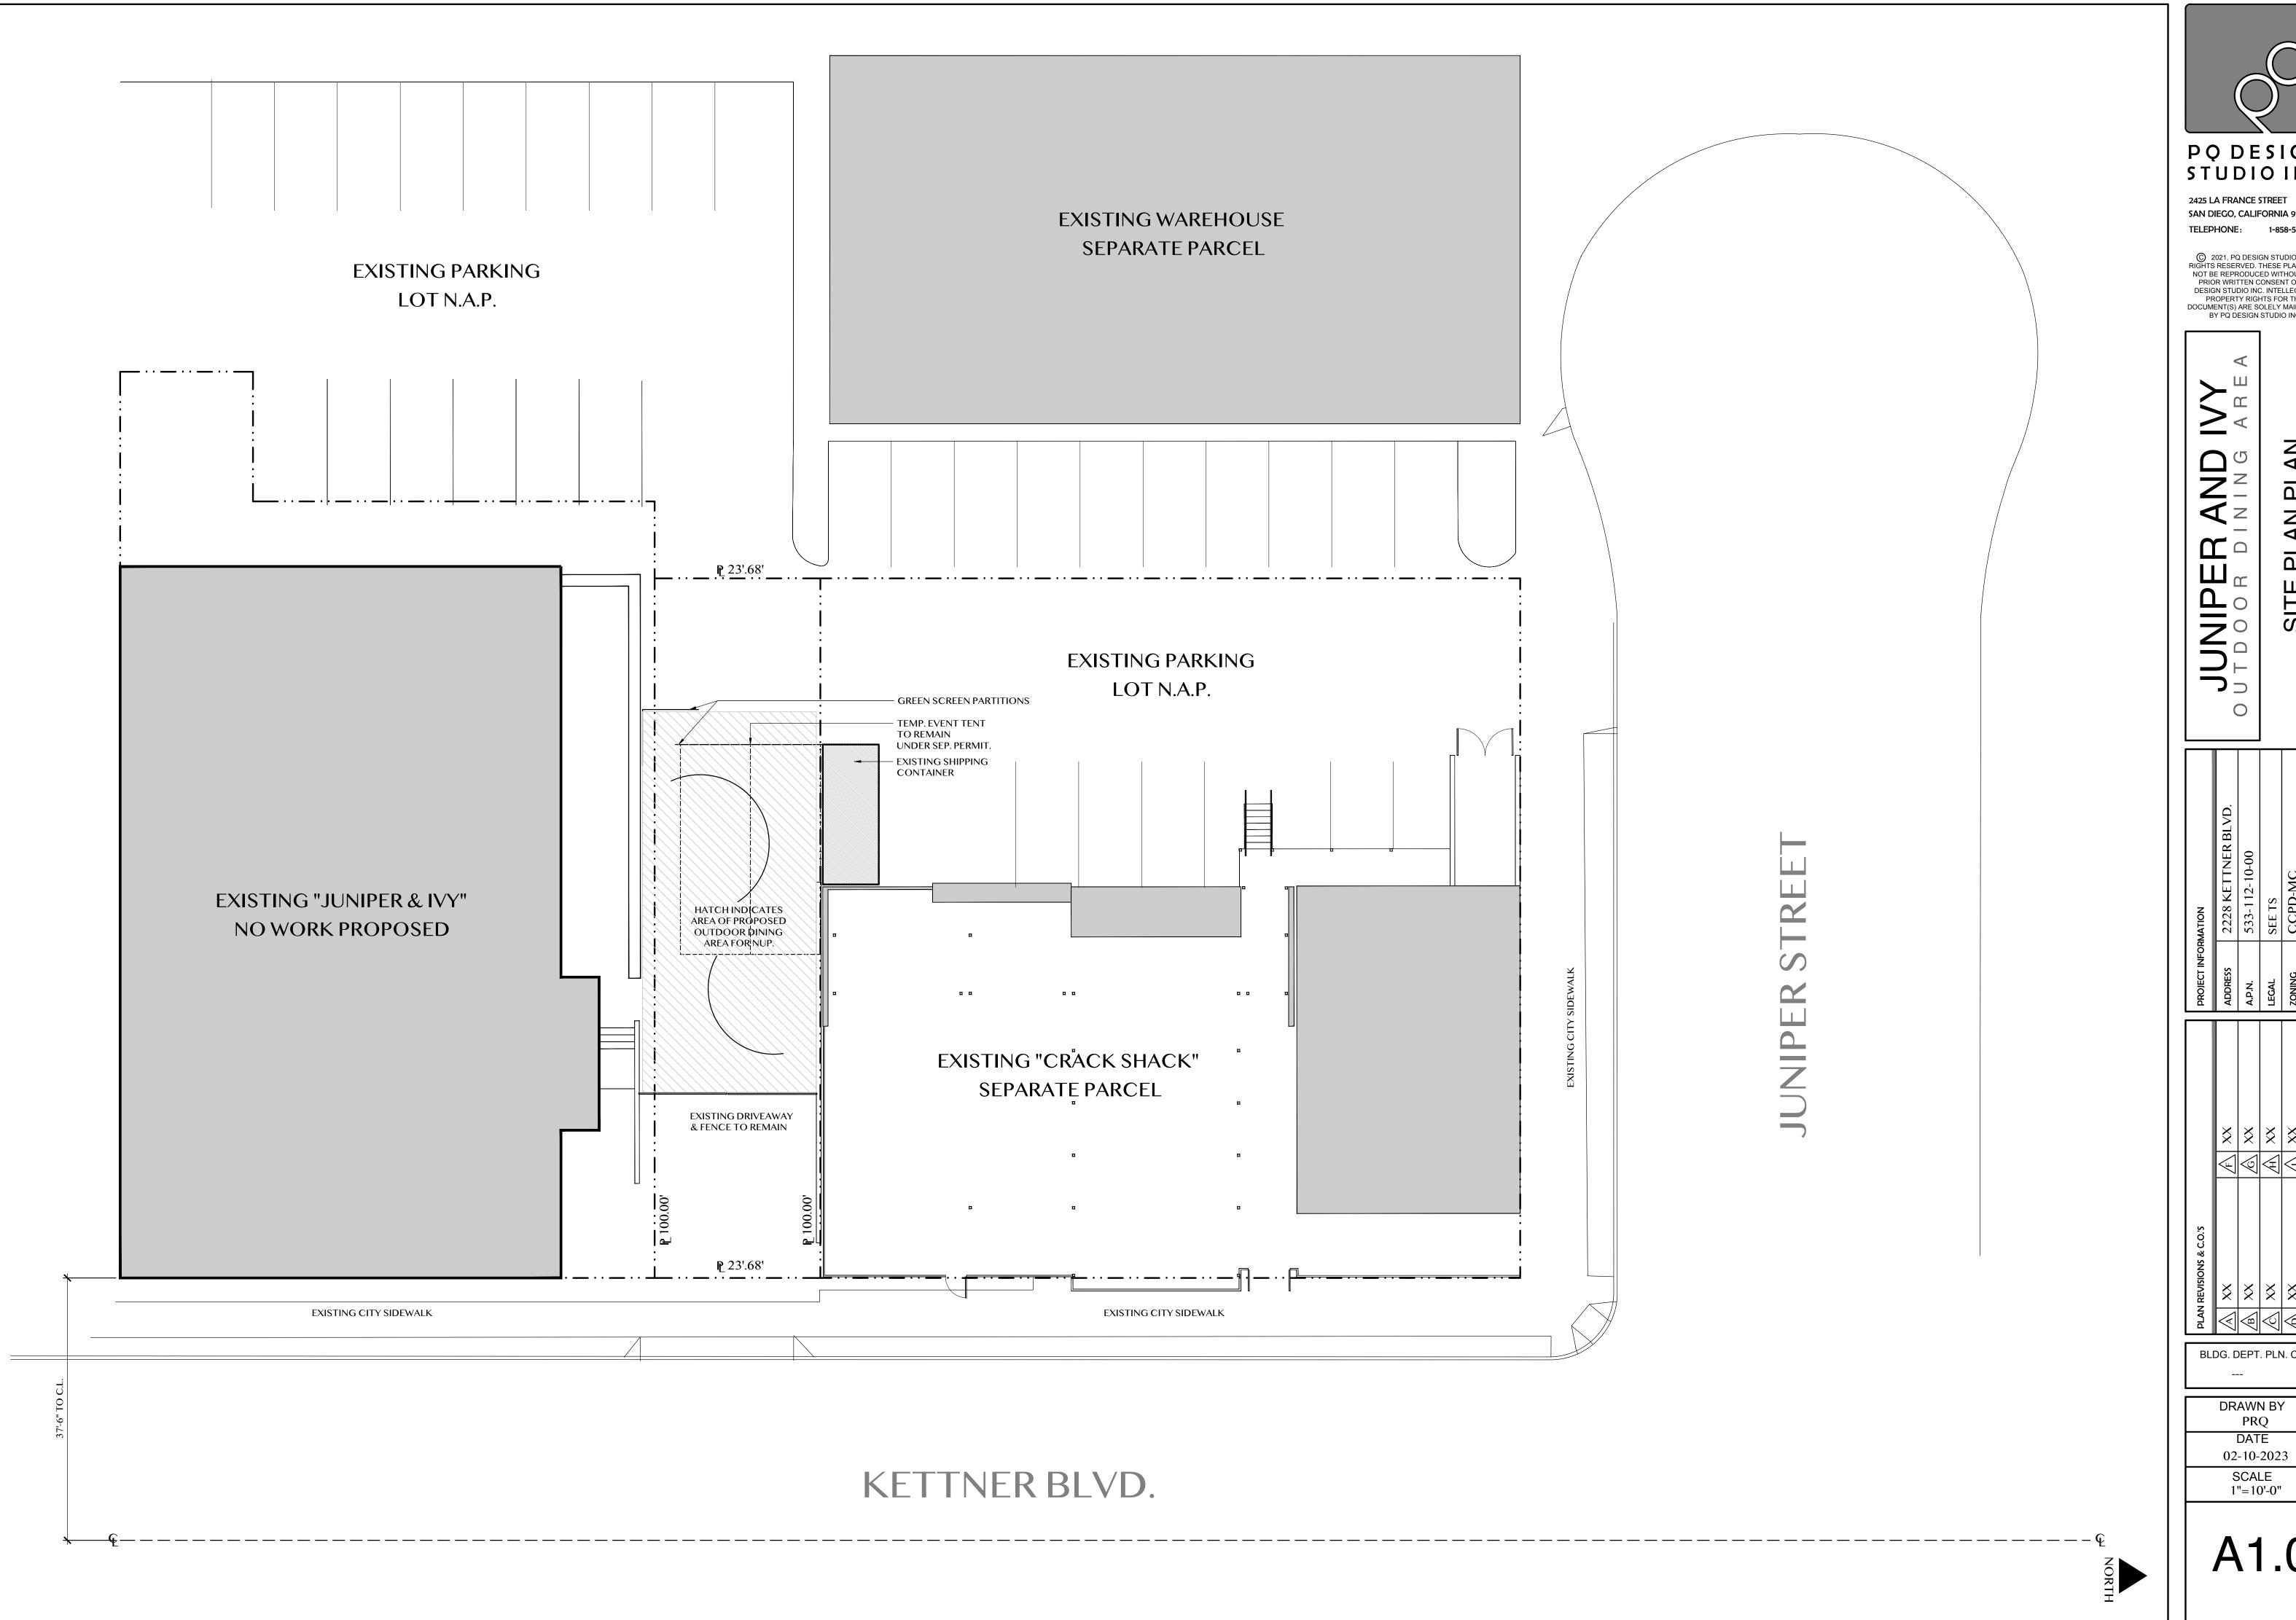



PQ DESIGN STUDIOINC


SAN DIEGO, CALIFORNIA 92109 TELEPHONE: 1-858-527-0818


© 2021, PQ DESIGN STUDIO. ALL RIGHTS RESERVED. THESE PLANS MAY NOT BE REPRODUCED WITHOUT THE PRIOR WRITTEN CONSENT OF PQ DESIGN STUDIO INC. INTELLECTUAL PROPERTY RIGHTS FOR THIS DOCUMENT(S) ARE SOLELY MAINTAINED BY PQ DESIGN STUDIO INC.

	XX	XX	XX	XX	XX
	A	$\nabla \!\!\!\!/$	$\overline{\mathbb{W}}$	$\bigvee$	$\bigvee$
PLAN REVISIONS & C.O.'S	XX	XX	XX	XX	XX
PLA		$\overline{\mathbb{B}}$	$\bigcirc$	9	E

BLDG. DEPT. PLN. CHK

DRAWN BY DATE 02-10-2023 SCALE 1"=10'-0"

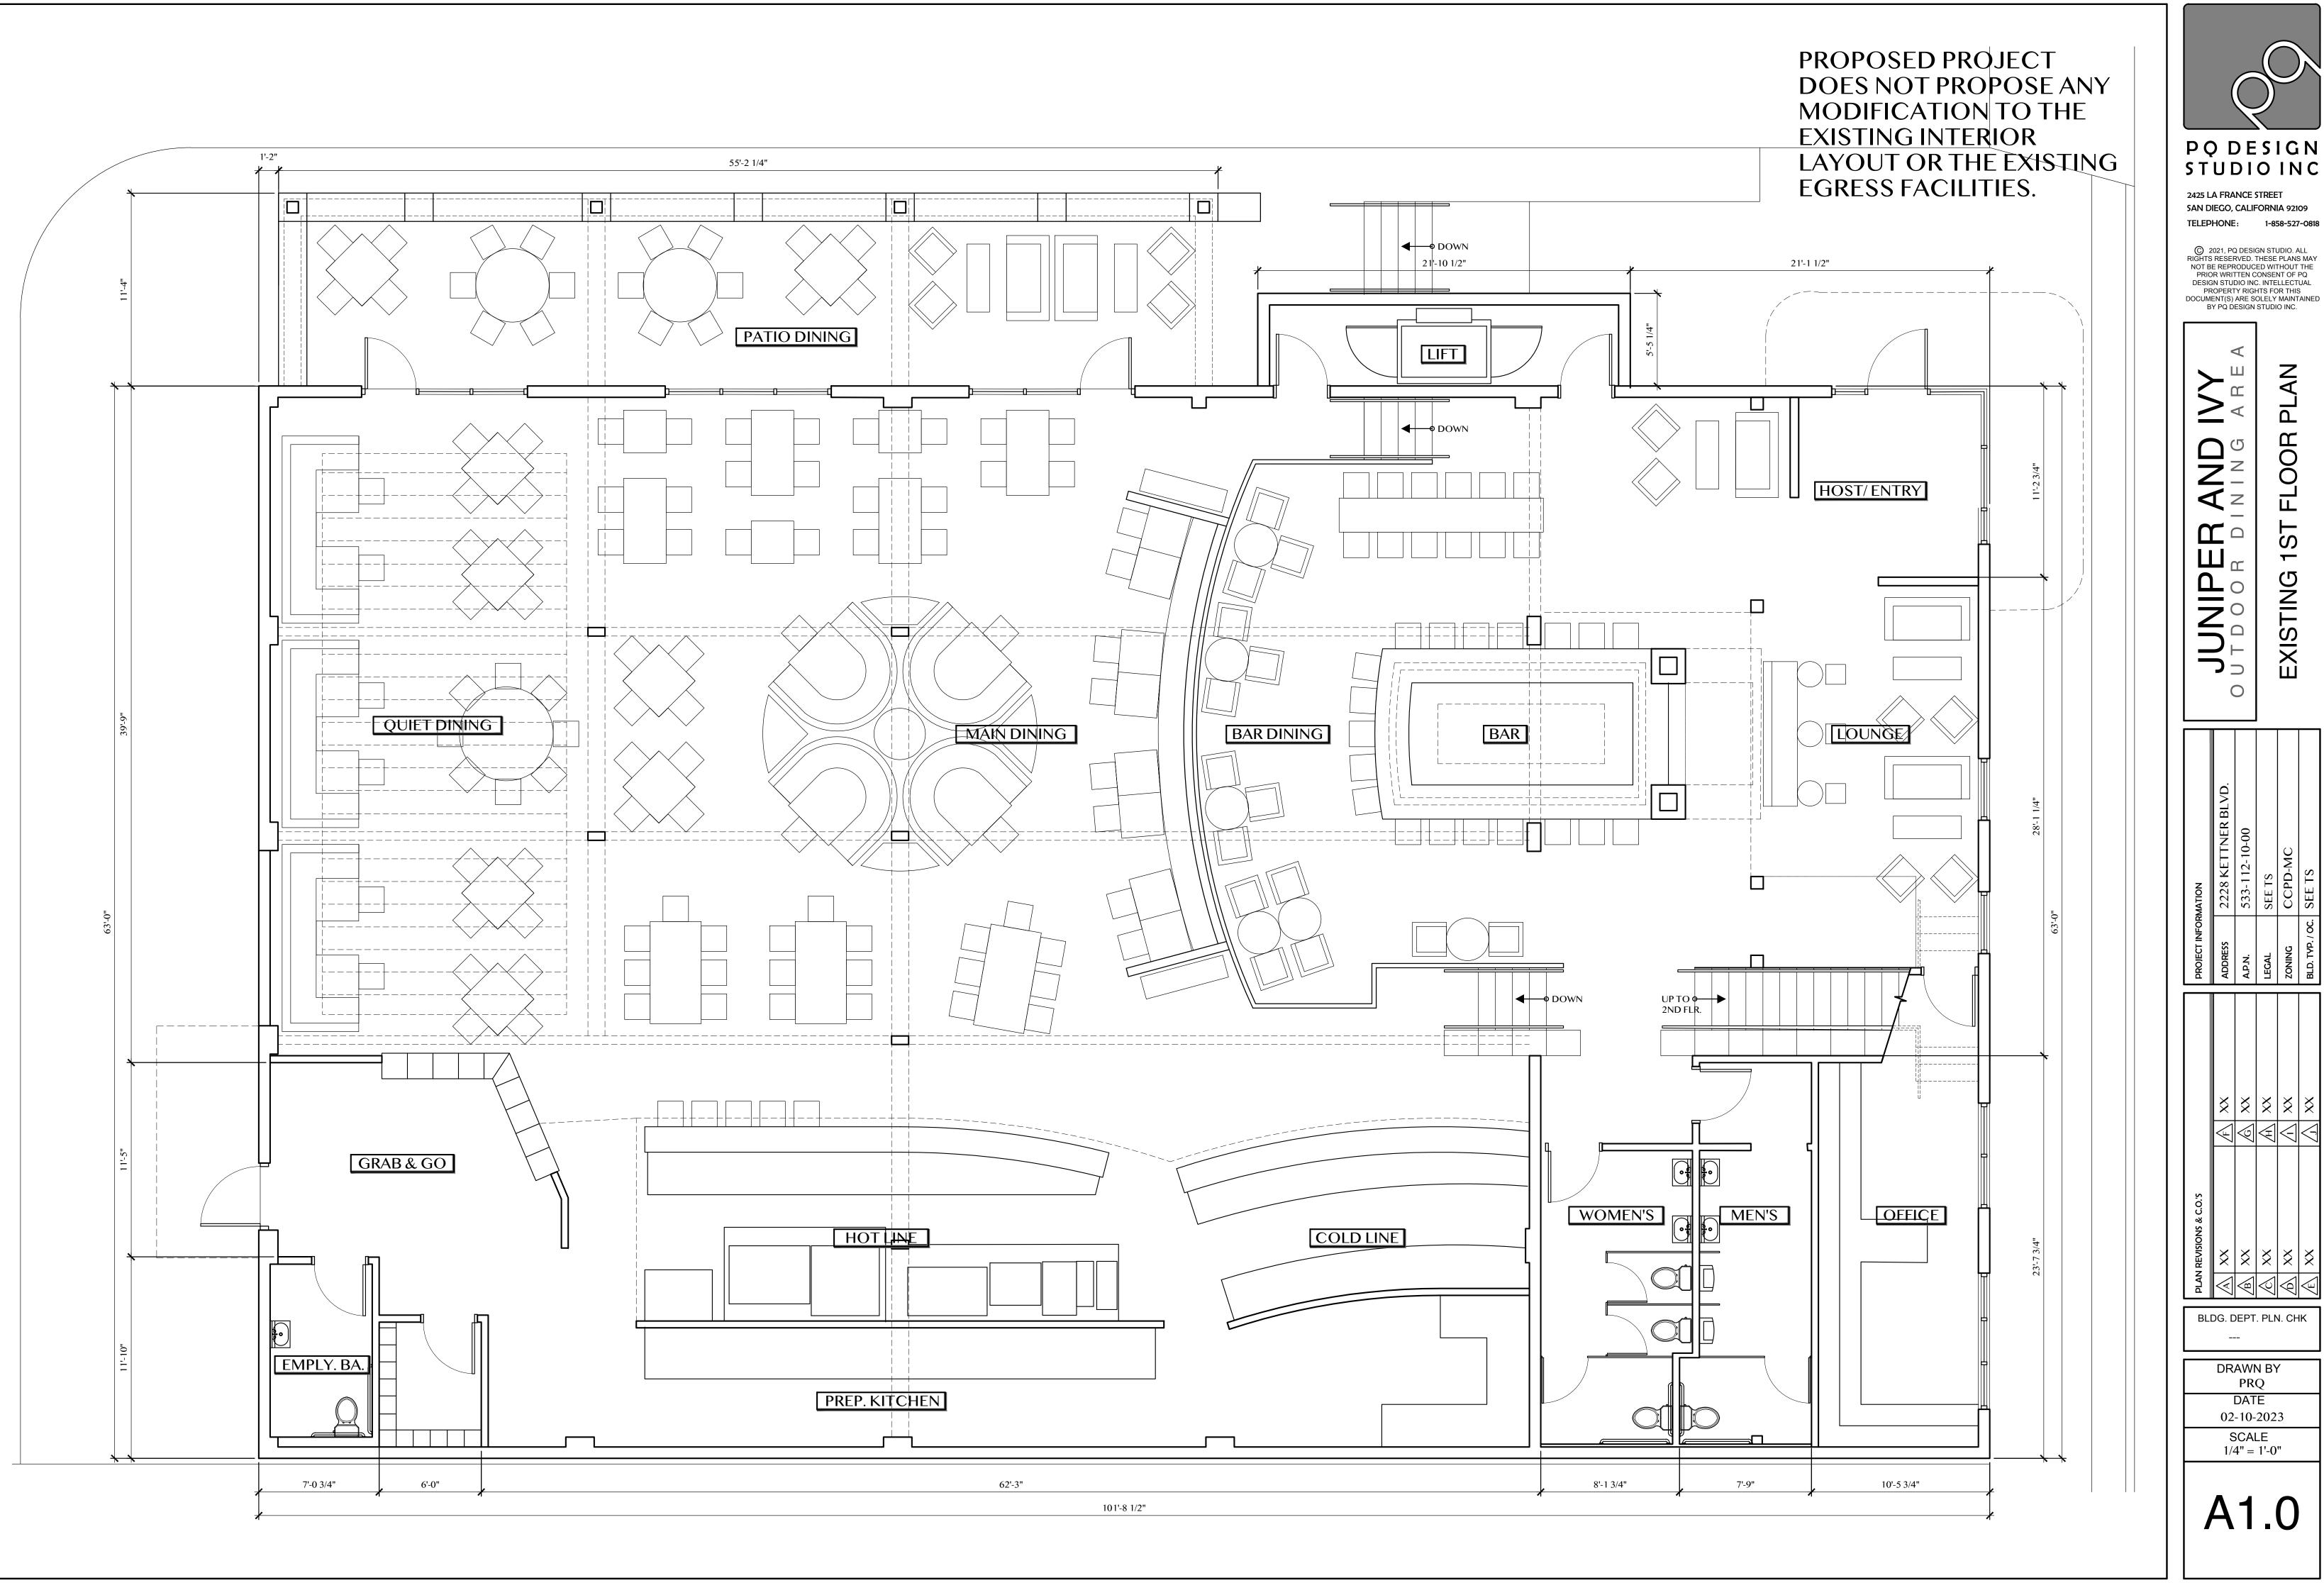

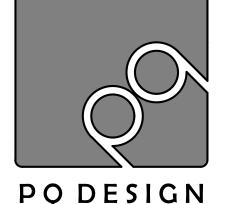


PQ DESIGN

© 2021, PQ DESIGN STUDIO. ALL RIGHTS RESERVED. THESE PLANS MAY NOT BE REPRODUCED WITHOUT THE PRIOR WRITTEN CONSENT OF PQ DESIGN STUDIO INC. INTELLECTUAL PROPERTY RIGHTS FOR THIS DOCUMENT(S) ARE SOLELY MAINTAINED

BY PQ DESIGN STUDIO INC.

BLDG. DEPT. PLN. CHK

02-10-2023

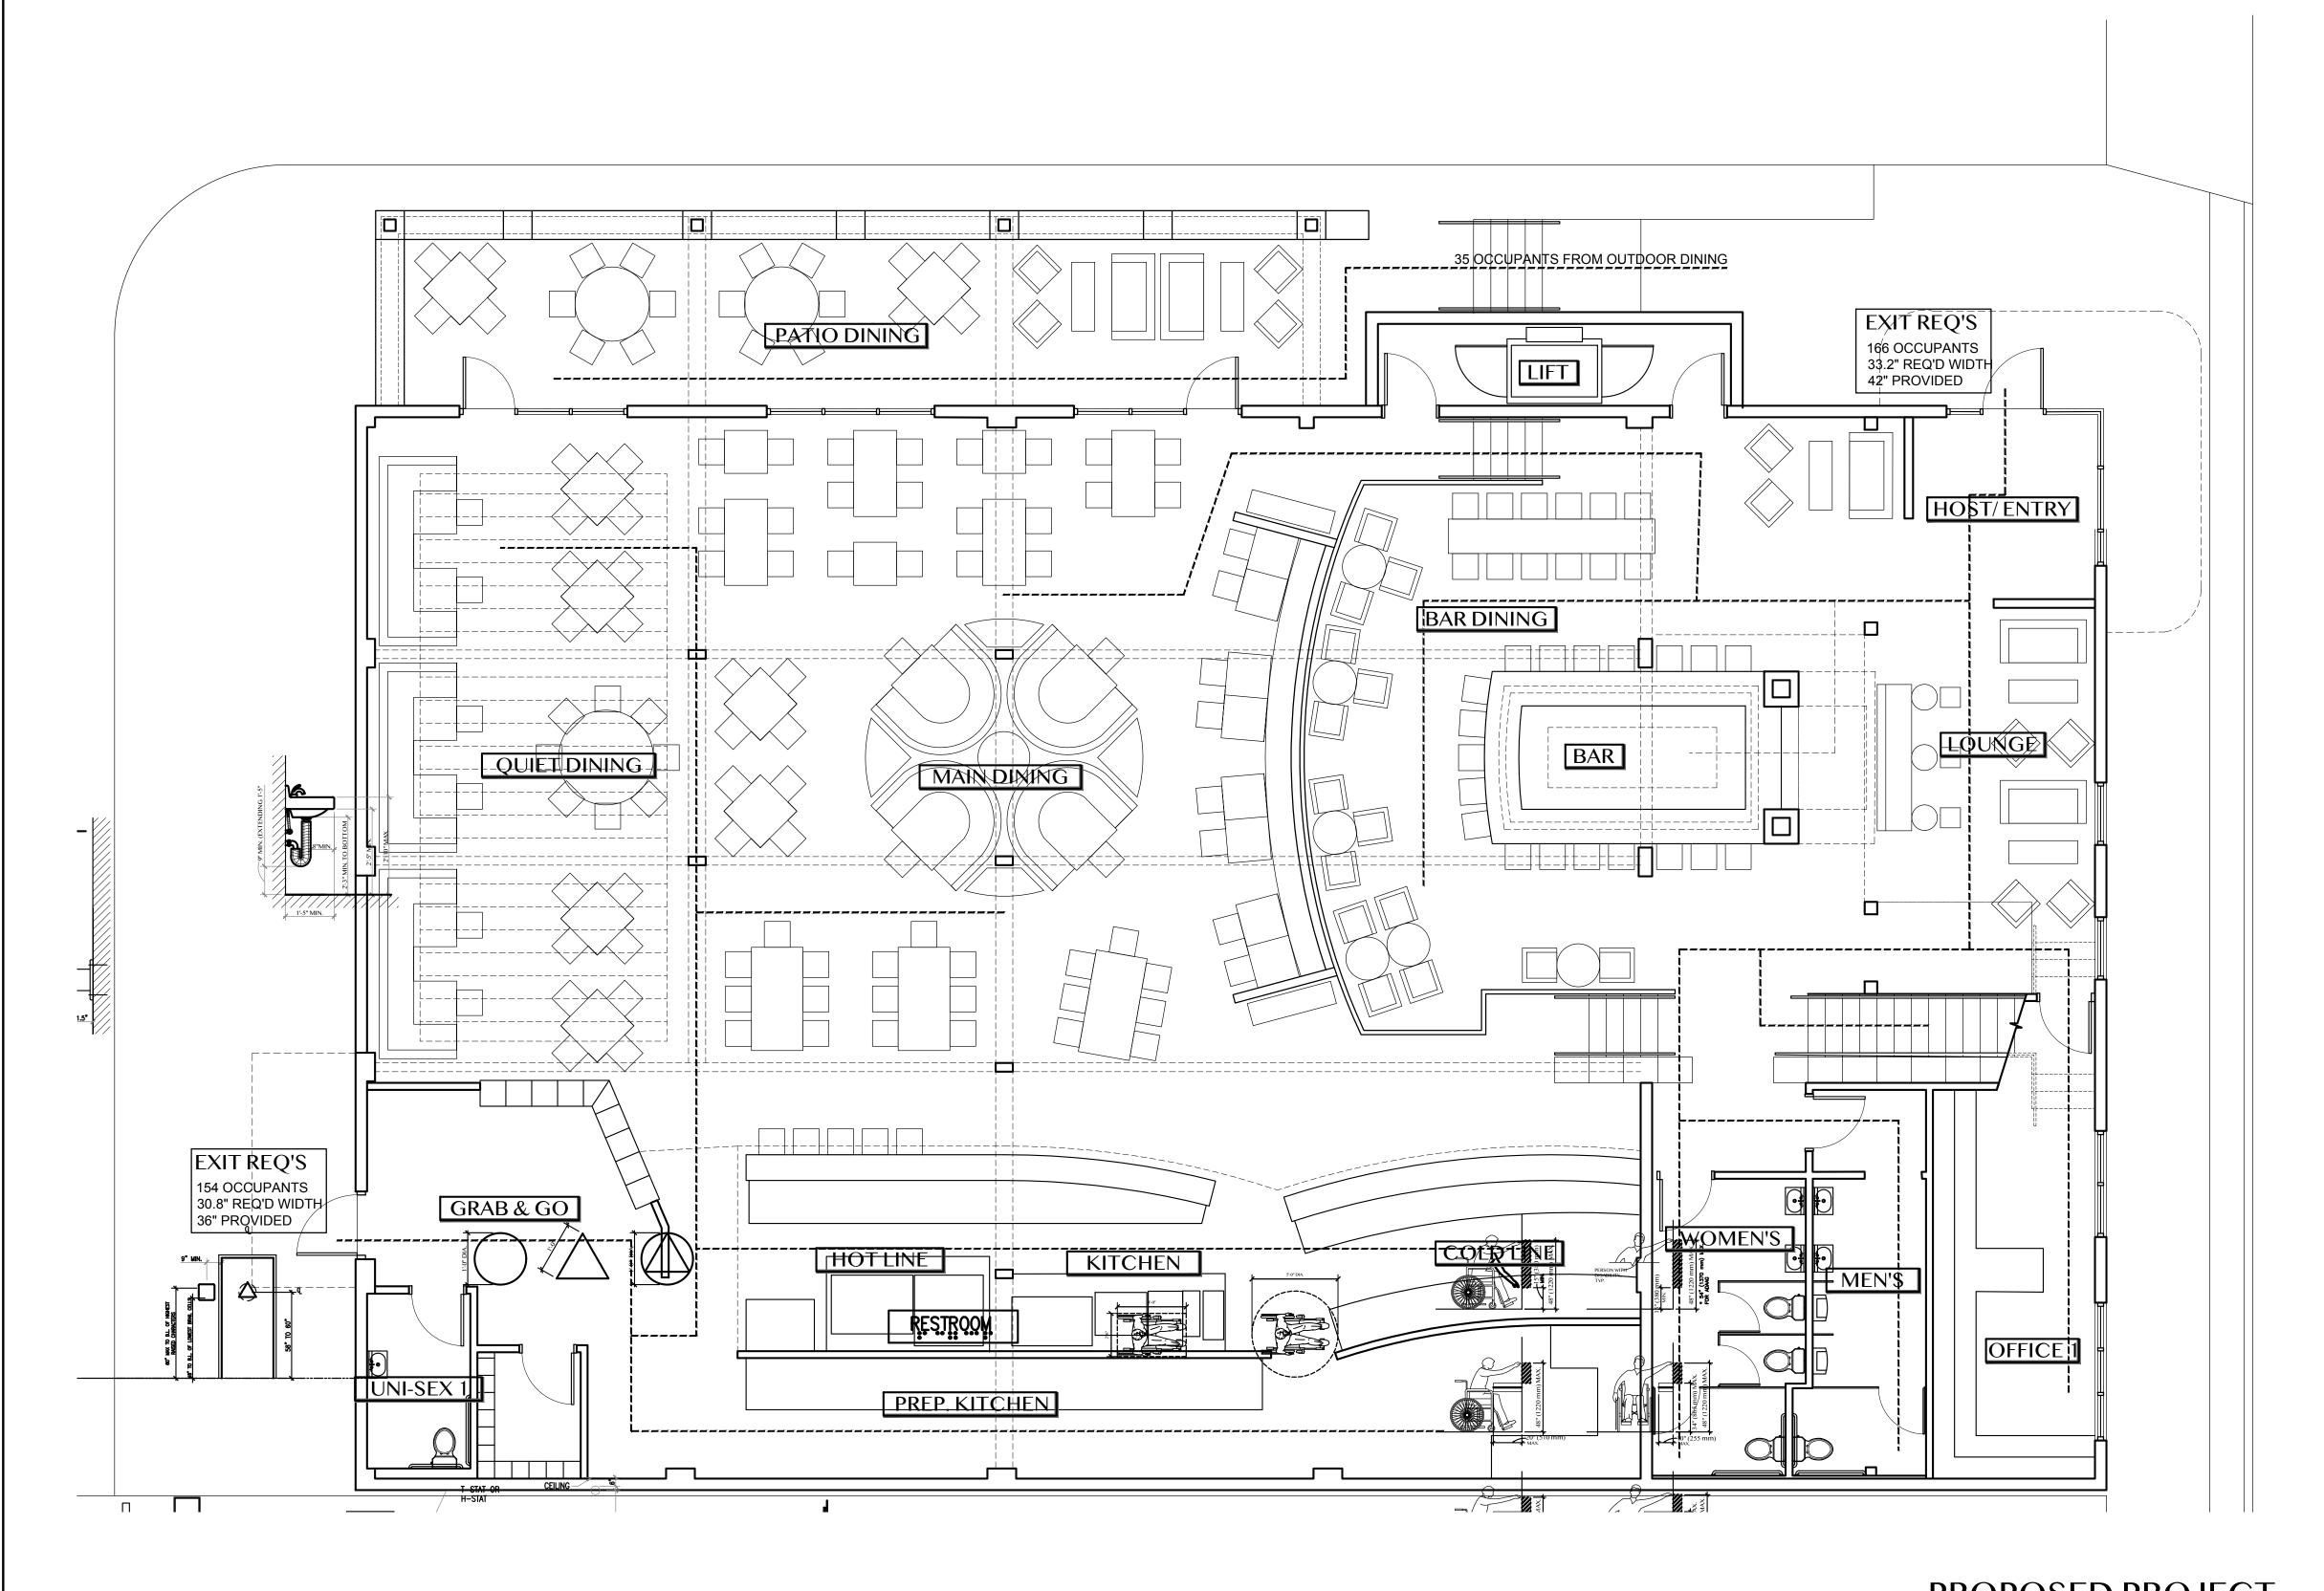

PROPOSED PROJECT DOES NOT PROPOSE ANY MODIFICATION TO THE **EXISTING INTERIOR** LAYOUT OR THE EXISTING EGRESS FACILITIES.

### SYMBOL KEY

—E—E— LOW LEVEL EXIT SIGNS (1011.7)



ILLUMINATED EXIT SIGN MOUNTED ABOVE DOOR



TACTILE "EXIT" SIGNAGE PER ICC A117.1 INSTALL PER 2/D2.0. SIGN PER 5/D2.0



TACTILE "EXIT ROUTE" SIGNAGE PER CBC 1011.3



& 1117B.5.1 INSTALL PER 2/D2.0. SIGN PER 5/D2.0

EMERGENCY LIGHT FIXTURE PER E-SHEET SCHED.

## OCCUPANT LOAD CALCS.

RESTUARANT OCCUPANCY USE CAT. A2 EXIT ACCESS TRAVEL DISTANCE(TABLE 1017.2) 200' MIN. NUMBER OF REQ'D EXITS (TABLE 1006.3.2)

#### EXISTING RESTAURANT FACILITY (EXISTING AND TO REMAIN)

	•		*
ROOM NAME	FLOOR AREA (SQ.FT.)	LOAD RATIO	OCCUPANTS
LOUNGE/ DINING AREAS (TOTAL)	4,369	1 / 15	291
KITCHEN AREAS (TOTAL)	1,519	1 / 200	8
BAR (NON-CUSTOMER AREA)	223	1 / 50	4
RECEPTION AREA	113	1 / 15	8
OFFICE 1	238	1 / 100	2
2ND FLOOR - PRIVATE DINING	540	1 / 15	36
2ND FLOOR - OFFICE 2	615	1 / 100	6
	<u>'</u>		-

355 TOTAL OCCUPANTS

NEW OUTDOOR DINING AREA (EGRESS PROVIDED INDEPENDENTLY)

TOTAL OCCUPANCY LOAD COUNT NUMBER OF EXITS PROVIDED 2-TOTAL

MAX EXIT DISTANCE IN PROJECT (FROM 2ND FLOOR PRIVATE DINING)

OUTDOOR DINING AREA (NEW) 1,290

# MISC. EGRESS PLAN NOTES

- EGRESS ILLUMINATION AND EXIT SIGNAGE LOCATIONS SUBJECTY TO REVIEW BY CITY BUILDING DIVISION AND FIRE DEPT. INSPECTORS (CBC 1008, 1013)
- 2. EGRESS DOORS MUST BE READILY OPENABLE FROM EGRESS SIDE WITHOUT USE OF A KEY OR ANY SPECIAL KNOWLEDGE OR EFFORT. UNLATCHING ANY OR OR LEAF SHALL NOT REQUIRE MORE THAN ONE OPERATION. (CBC 1010.1.9)
- 3. MANUALLY OPERATED FLUSH BOLTS OR SURFACE BOLTS ARE NOT PERMITTED ON ANY DOORS (CBC 1010.1.9.4)
- 4. OCCUPANCY LOAD TO BE POSTED IN A CONSPICUOUS PLACE, NEAR THE MAIN EXIT ACCESS DOORWAY FROM THE ROOM OR SPACE.

## FIXTURE OCCUPANCY CALCS.

ROOM NAME	FLOOR AREA (SQ.FT.)	LOAD RATIO	OCCUPANT
LOUNGE/ DINING AREAS (TOTAL)	4,369	1 / 30	146
KITCHEN AREAS (TOTAL)	1,519	1 / 50	30
BAR (NON-CUSTOMER AREA)	223	1 / 50	5
RECEPTION AREA	113	1 / 15	8
OFFICE 1	238	1 / 150	2
2ND FLOOR - PRIVATE DINING	540	1 / 30	18
2ND FLOOR - OFFICE 2	615	1 / 150	4
OUTDOOR DINING AREA (NEW)	1,290	1 / 30	43

TOTALFIXTURE OCCUPANCY LOAD

256 TOTAL 128 MEN / 128 WOMEN

REQUIRED FIXTURE COUNTS (PER CPC 4-1)


UNI-SEX 2

PQ DESIGN STUDIOINC

2425 LA FRANCE STREET SAN DIEGO, CALIFORNIA 92109 TELEPHONE: 1-858-527-0818

© 2021, PQ DESIGN STUDIO. ALL NOT BE REPRODUCED WITHOUT THE PRIOR WRITTEN CONSENT OF PQ DESIGN STUDIO INC. INTELLECTUAL PROPERTY RIGHTS FOR THIS DOCUMENT(S) ARE SOLELY MAINTAINED

BY PQ DESIGN STUDIO INC.

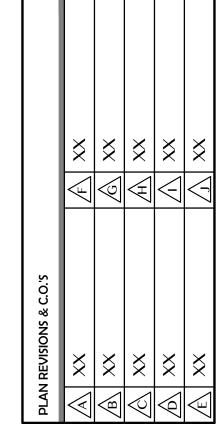


BLDG. DEPT. PLN. CHK

DRAWN BY DATE 02-10-2023

SCALE 3/16"=1'-0"

PROPOSED PROJECT DOES NOT PROPOSE ANY MODIFICATION TO THE **EXISTING INTERIOR** LAYOUT OR THE EXISTING EGRESS FACILITIES.



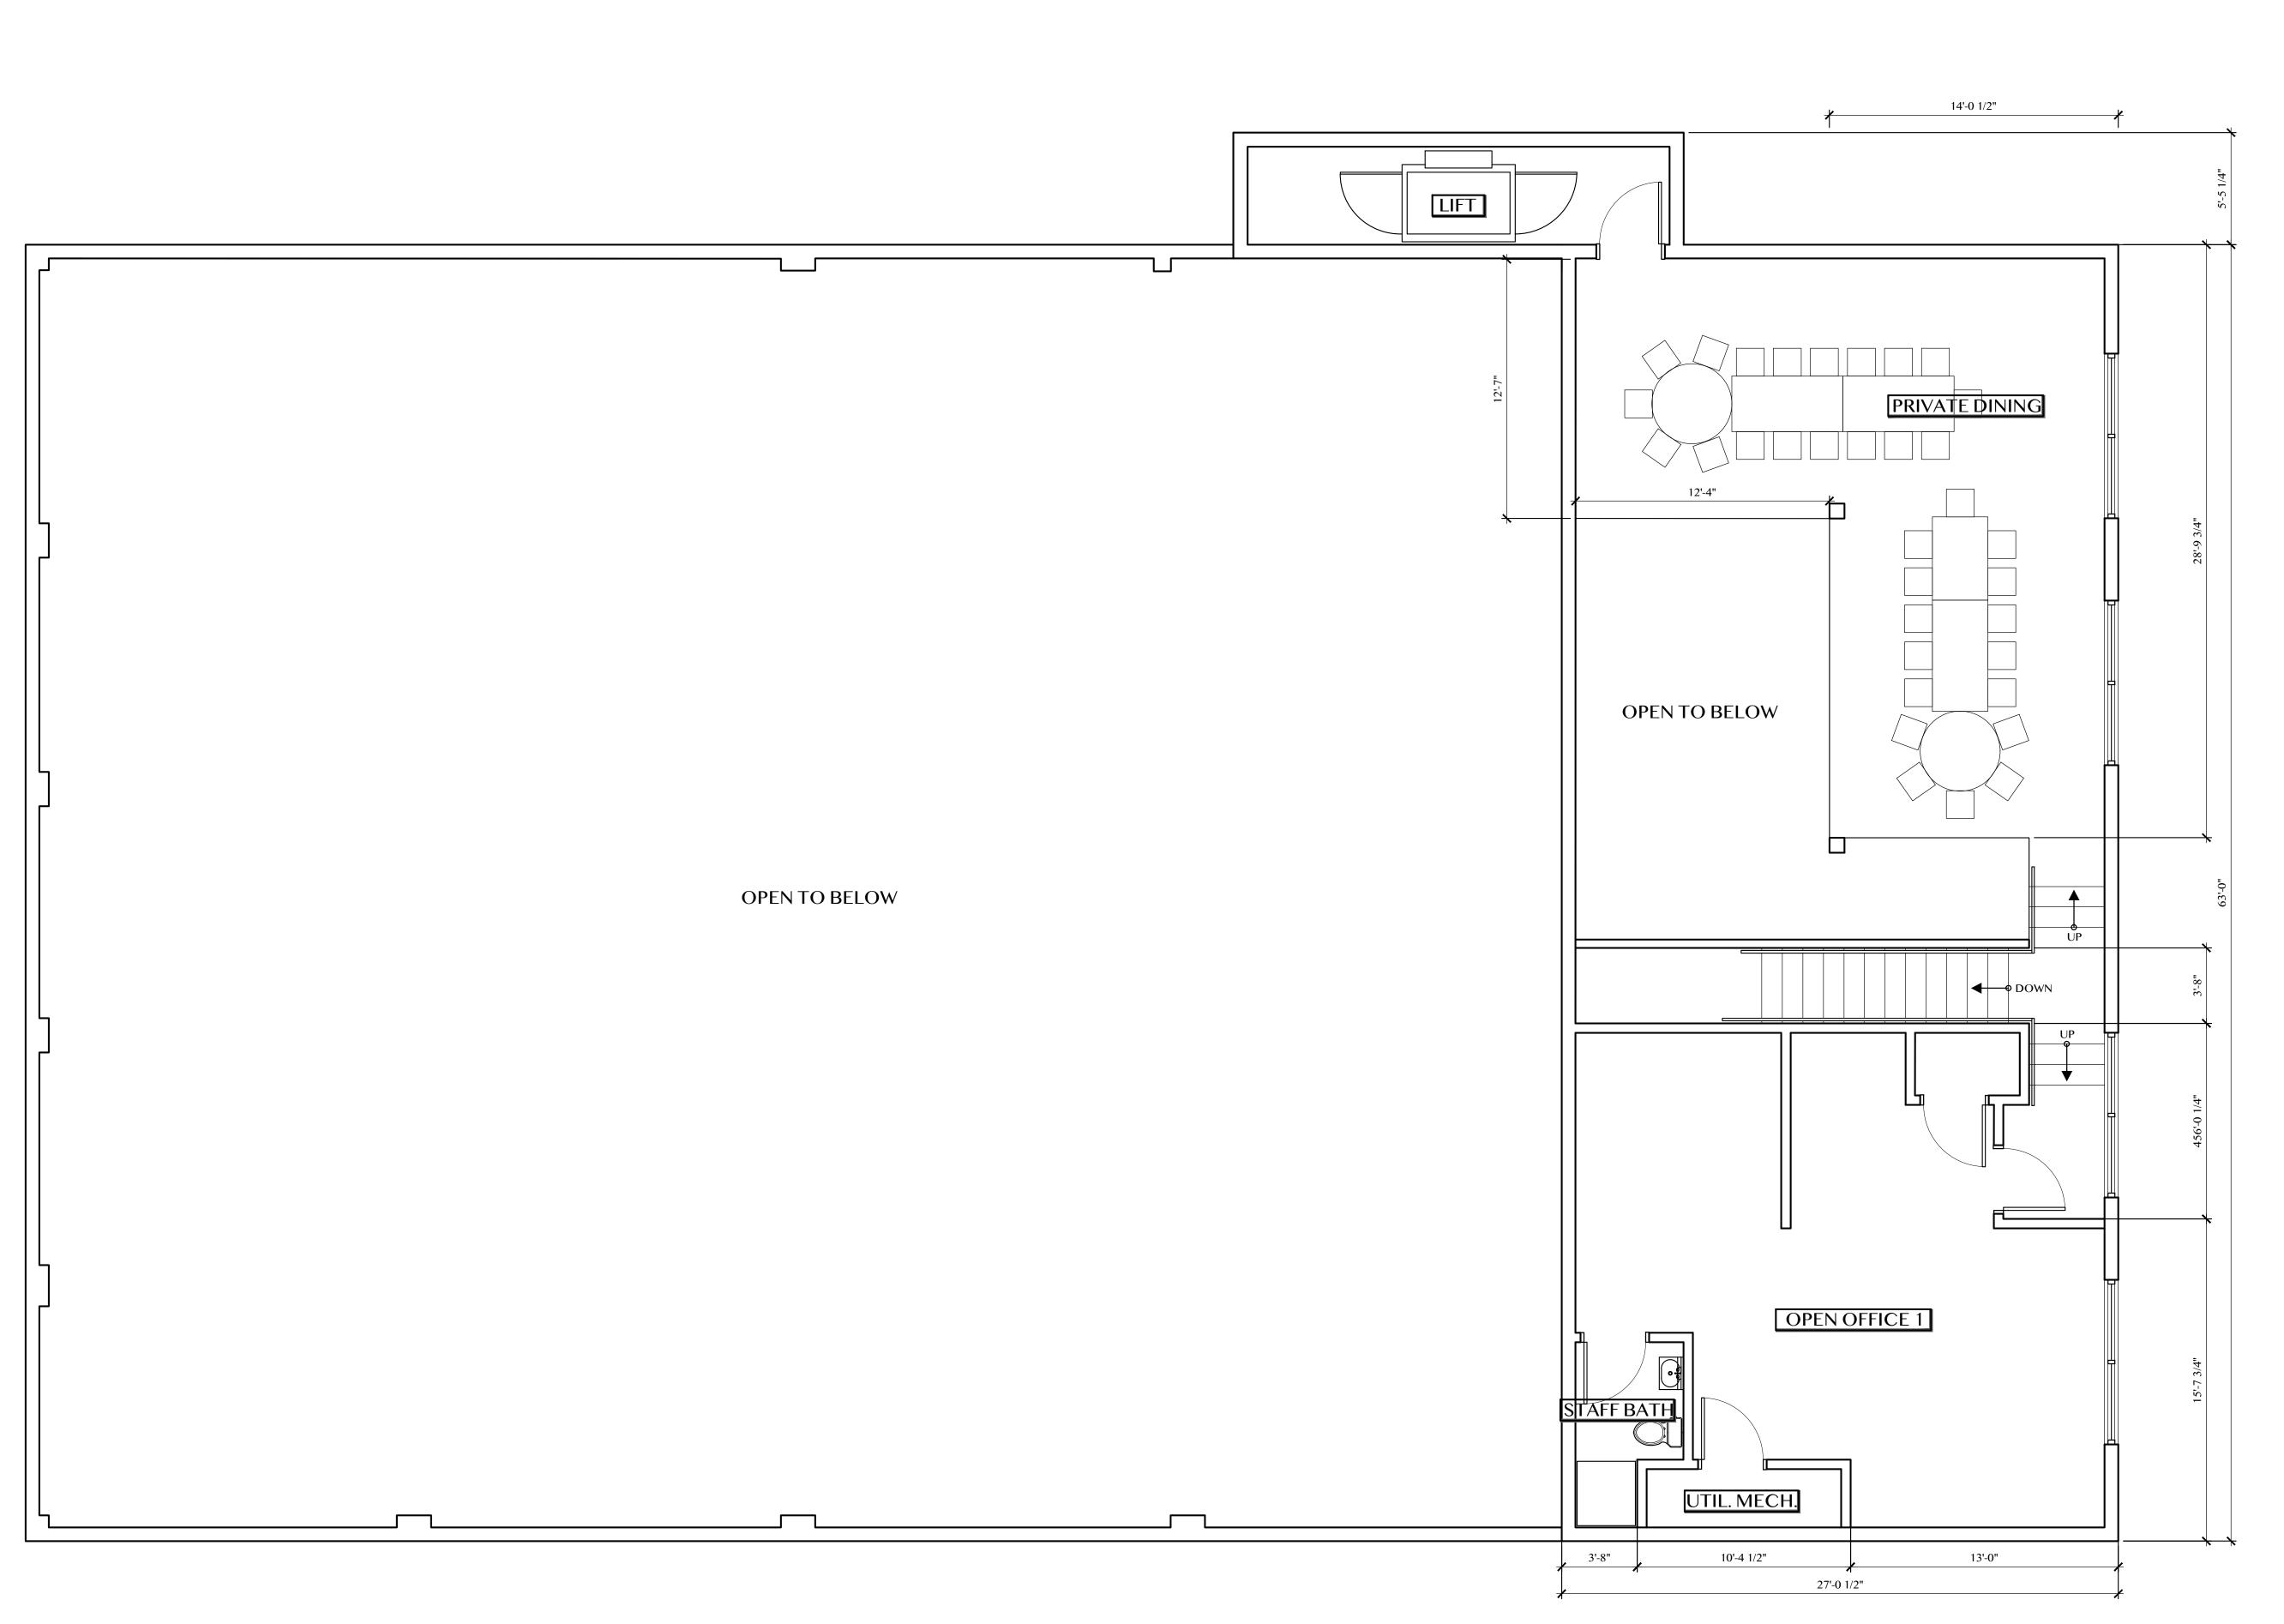


STUDIOINC

2425 LA FRANCE STREET SAN DIEGO, CALIFORNIA 92109

TELEPHONE: 1-858-527-0818


© 2021, PQ DESIGN STUDIO. ALL RIGHTS RESERVED. THESE PLANS MAY NOT BE REPRODUCED WITHOUT THE PRIOR WRITTEN CONSENT OF PQ DESIGN STUDIO INC. INTELLECTUAL PROPERTY RIGHTS FOR THIS DOCUMENT(S) ARE SOLELY MAINTAINED BY PQ DESIGN STUDIO INC.

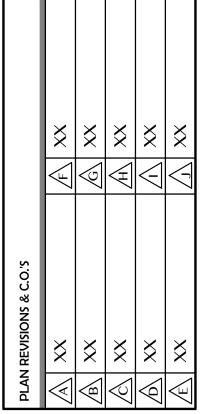

BLDG. DEPT. PLN. CHK

DRAWN BY DATE 02-10-2023 SCALE 1/4" = 1'-0"

PROPOSED PROJECT DOES NOT PROPOSE ANY MODIFICATION TO THE **EXISTING INTERIOR** LAYOUT OR THE EXISTING EGRESS FACILITIES.

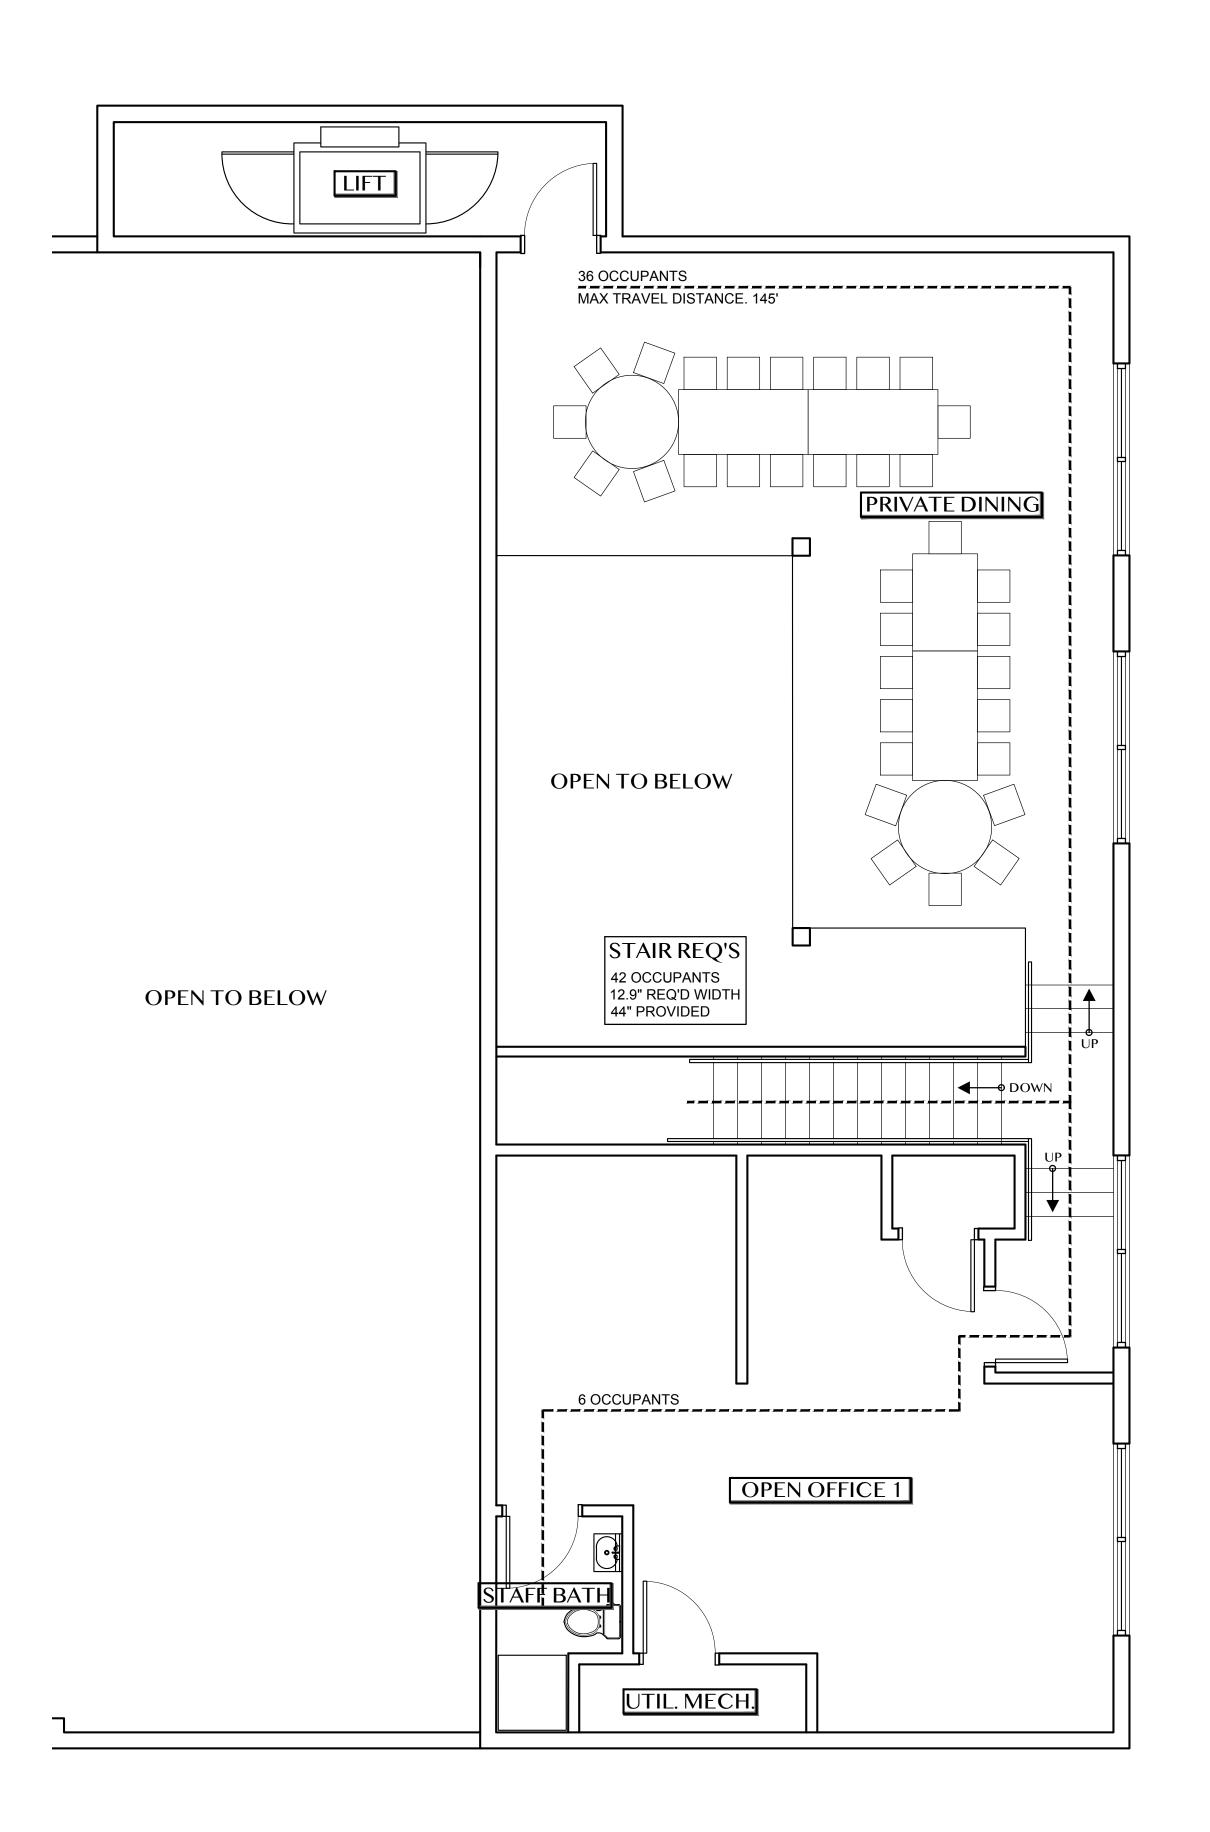

### SYMBOL KEY

—E—E— LOW LEVEL EXIT SIGNS (1011.7)

ILLUMINATED EXIT SIGN MOUNTED ABOVE DOOR



TACTILE "EXIT" SIGNAGE PER ICC A117.1 INSTALL PER 2/D2.0. SIGN PER 5/D2.0



TACTILE "EXIT ROUTE" SIGNAGE PER CBC 1011.3 & 1117B.5.1 INSTALL PER 2/D2.0. SIGN PER 5/D2.0



EMERGENCY LIGHT FIXTURE PER E-SHEET SCHED.

## OCCUPANT LOAD CALCS.

RESTUARANT OCCUPANCY USE CAT. A2 EXIT ACCESS TRAVEL DISTANCE(TABLE 1017.2) 200' MIN. NUMBER OF REQ'D EXITS (TABLE 1006.3.2)

#### EXISTING RESTAURANT FACILITY (EXISTING AND TO REMAIN)

ROOM NAME	FLOOR AREA (SQ.FT.)	LOAD RATIO	OCCUPANTS
LOUNGE/ DINING AREAS (TOTAL)	4,369	1 / 15	291
KITCHEN AREAS (TOTAL)	1,519	1 / 200	8
BAR (NON-CUSTOMER AREA)	223	1 / 50	4
RECEPTION AREA	113	1 / 15	8
OFFICE 1	238	1 / 100	2
2ND FLOOR - PRIVATE DINING	540	1 / 15	36
2ND FLOOR - OFFICE 2	615	1 / 100	6
		355 T	OTAL OCCUPANTS

NUMBER OF EXITS PROVIDED	
MAX EXIT DISTANCE IN PROJECT	

NEW OUTDOOR DINING AREA (EGRESS PROVIDED INDEPENDENTLY)					
	OUTDOOR DINING AREA (NEW)	1 / 15	86		
	NUMBER OF EXITS PROVI	2-TOTAL			
	MAX EXIT DISTANCE IN PE	60'			

### MISC. EGRESS PLAN NOTES

1. EGRESS ILLUMINATION AND EXIT SIGNAGE LOCATIONS SUBJECTY TO REVIEW BY CITY BUILDING DIVISION AND FIRE DEPT. INSPECTORS (CBC 1008, 1013) 2. EGRESS DOORS MUST BE READILY OPENABLE FROM EGRESS SIDE WITHOUT USE OF A

KEY OR ANY SPECIAL KNOWLEDGE OR EFFORT. UNLATCHING ANY OR OR LEAF SHALL NOT REQUIRE MORE THAN ONE OPERATION. (CBC 1010.1.9) 3. MANUALLY OPERATED FLUSH BOLTS OR SURFACE BOLTS ARE NOT PERMITTED ON ANY DOORS (CBC 1010.1.9.4)

4. OCCUPANCY LOAD TO BE POSTED IN A CONSPICUOUS PLACE, NEAR THE MAIN EXIT ACCESS DOORWAY FROM THE ROOM OR SPACE.

## FIXTURE OCCUPANCY CALCS.

ROOM NAME	FLOOR AREA (SQ.FT.)	LOAD RATIO	OCCUPANTS
LOUNGE/ DINING AREAS (TOTAL)	4,369	1 / 30	146
KITCHEN AREAS (TOTAL)	1,519	1 / 50	30
BAR (NON-CUSTOMER AREA)	223	1 / 50	5
RECEPTION AREA	113	1 / 15	8
OFFICE 1	238	1 / 150	2
2ND FLOOR - PRIVATE DINING	540	1 / 30	18
2ND FLOOR - OFFICE 2	615	1 / 150	4
OUTDOOR DINING AREA (NEW)	1,290	1 / 30	43

TOTALFIXTURE OCCUPANCY LOAD

REQUIRED FIXTURE COUNTS (PER CPC 4-1)

PROVIDED FIXTURE COUNTS WOMEN 4

UNI-SEX 2

2-TOTAL

256 TOTAL

128 MEN / 128 WOMEN

PQ DESIGN

STUDIOINC


TELEPHONE: 1-858-527-0818

© 2021, PQ DESIGN STUDIO. ALL RIGHTS RESERVED. THESE PLANS MAY

NOT BE REPRODUCED WITHOUT THE PRIOR WRITTEN CONSENT OF PQ DESIGN STUDIO INC. INTELLECTUAL PROPERTY RIGHTS FOR THIS

DOCUMENT(S) ARE SOLELY MAINTAINED BY PQ DESIGN STUDIO INC.


2425 LA FRANCE STREET SAN DIEGO, CALIFORNIA 92109

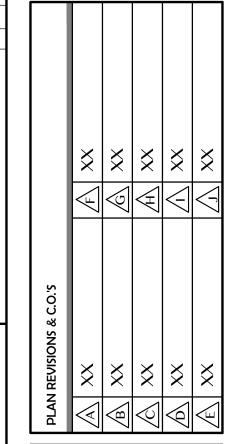

BLDG. DEPT. PLN. CHK

DRAWN BY DATE 02-10-2023 SCALE

1/4" = 1'-0"

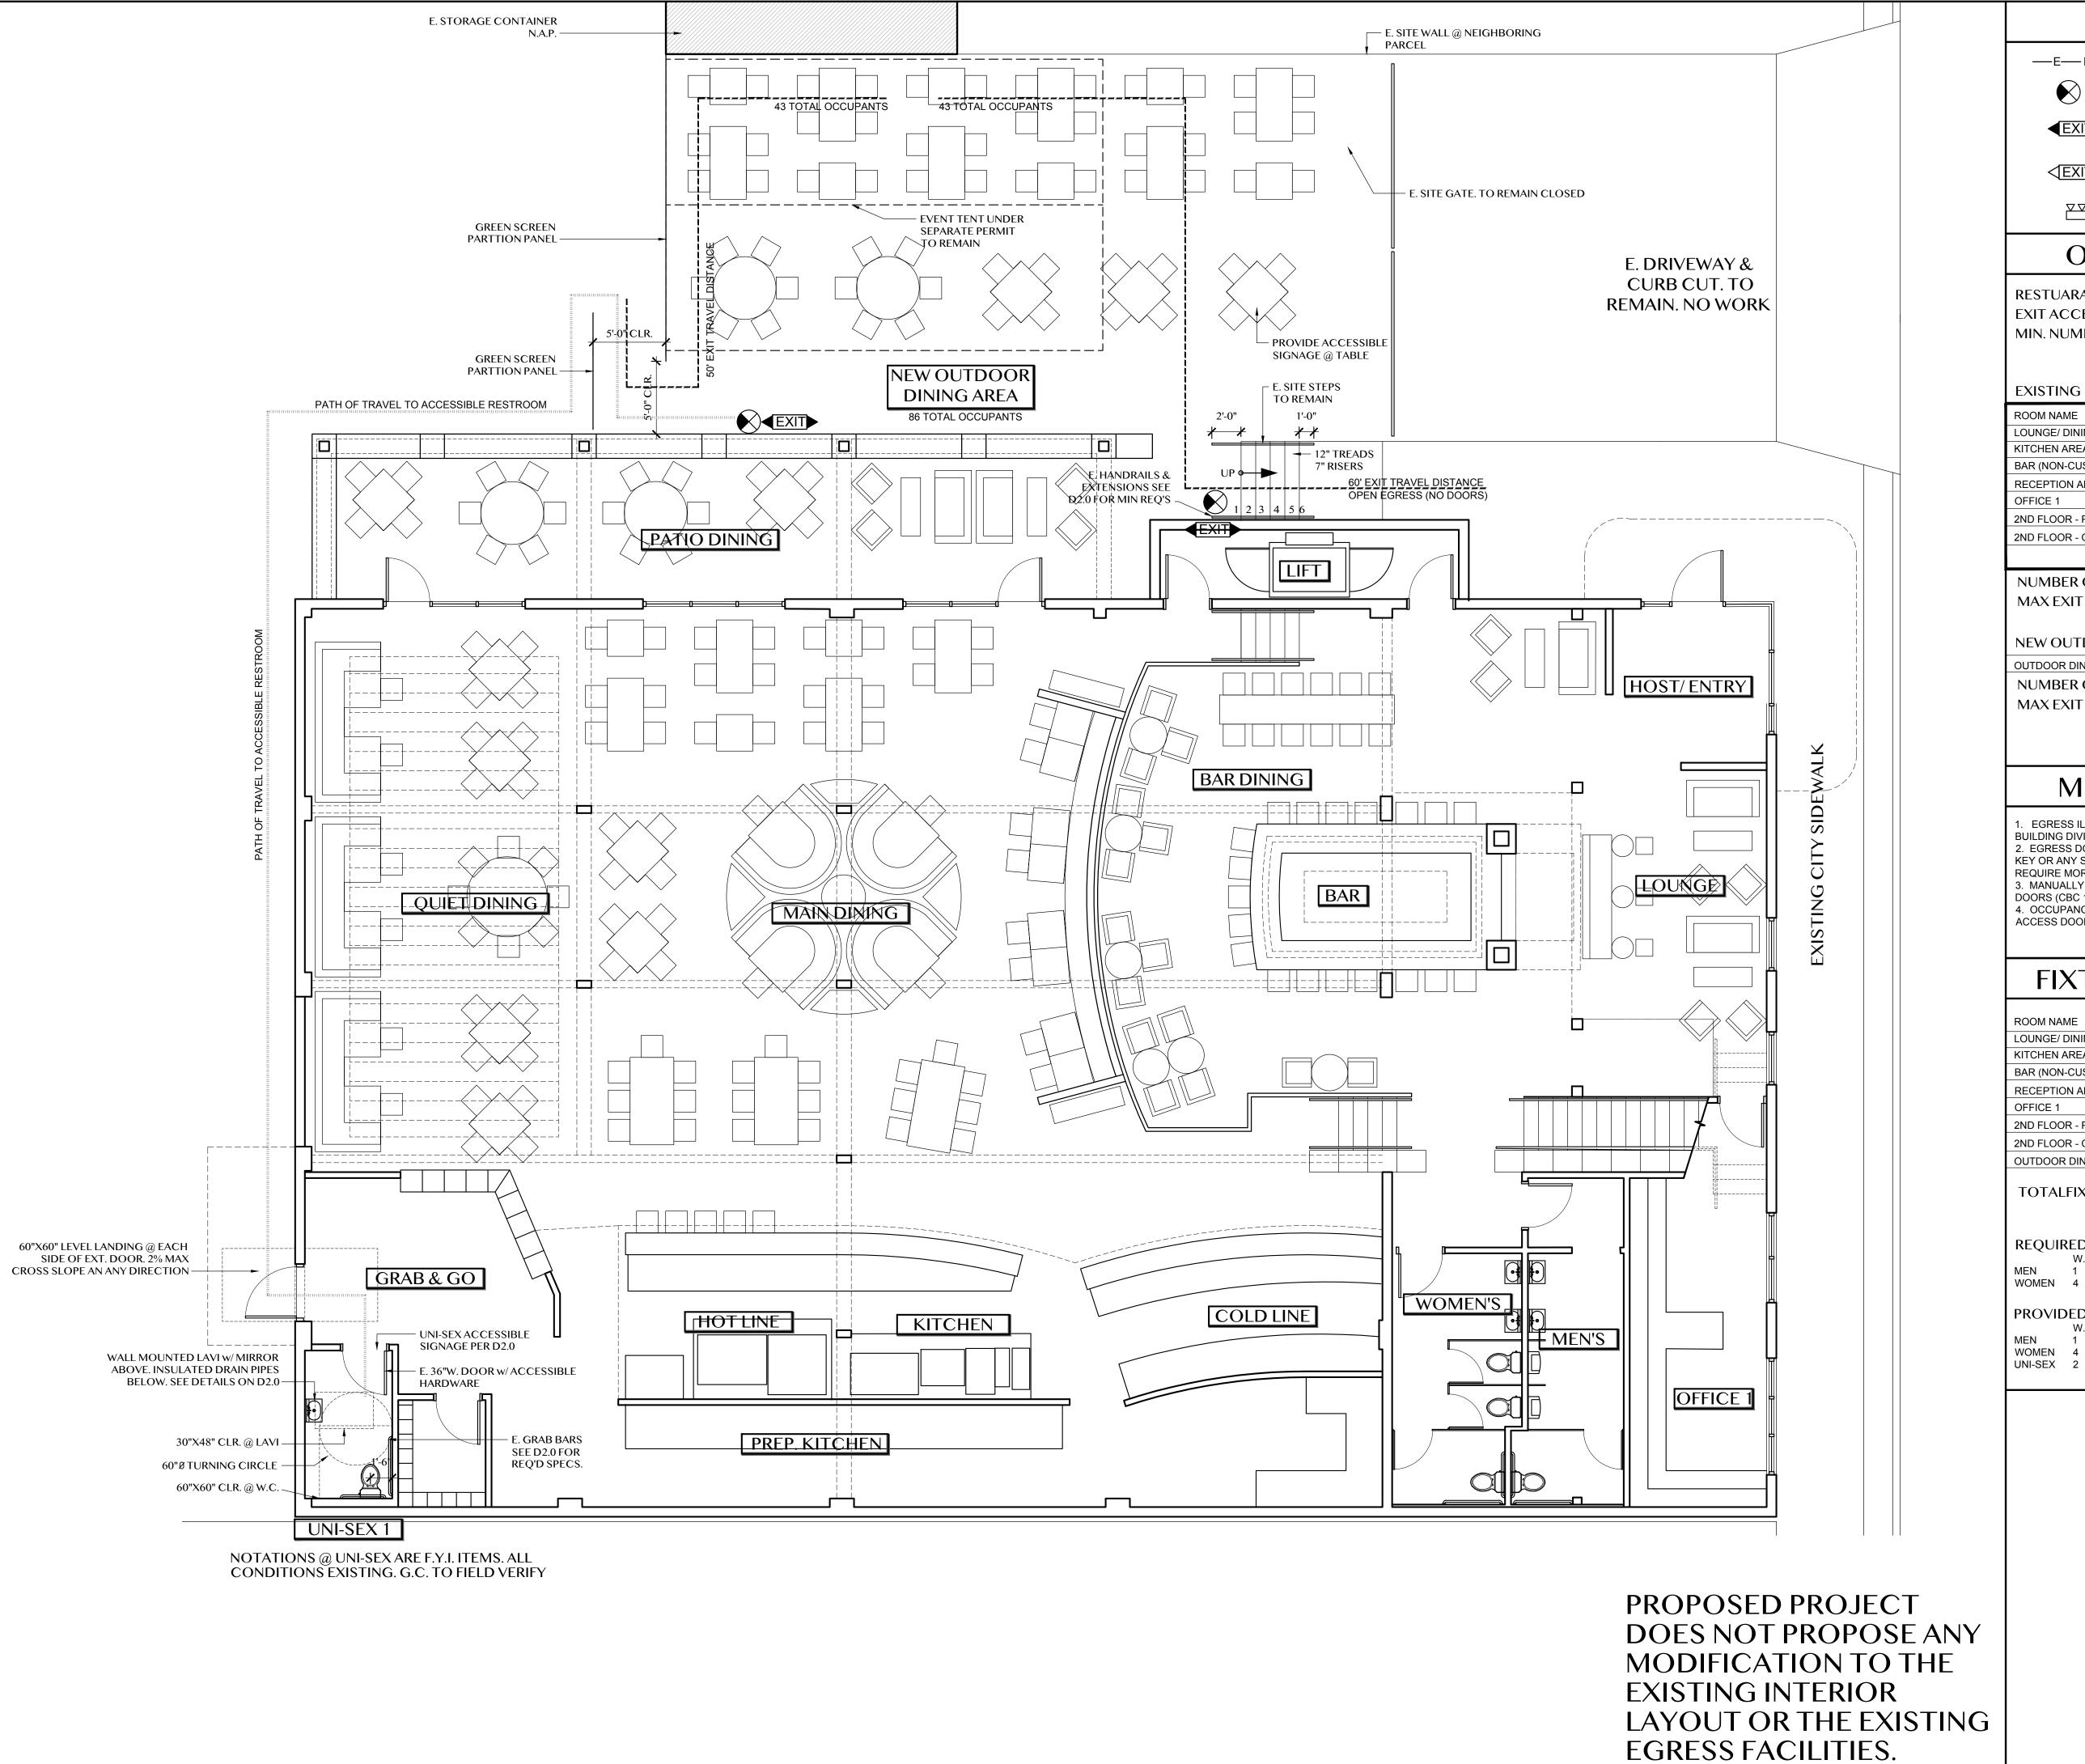

### SYMBOL KEY

—E—E— LOW LEVEL EXIT SIGNS (1011.7)

ILLUMINATED EXIT SIGN MOUNTED ABOVE DOOR



TACTILE "EXIT" SIGNAGE PER ICC A117.1 INSTALL PER 2/D2.0. SIGN PER 5/D2.0



TACTILE "EXIT ROUTE" SIGNAGE PER CBC 1011.3 & 1117B.5.1 INSTALL PER 2/D2.0. SIGN PER 5/D2.0



EMERGENCY LIGHT FIXTURE PER E-SHEET SCHED.

## OCCUPANT LOAD CALCS.

RESTUARANT OCCUPANCY USE CAT. A3 EXIT ACCESS TRAVEL DISTANCE(TABLE 1017.2) 200' MIN. NUMBER OF REQ'D EXITS (TABLE 1006.3.2)

#### EXISTING RESTAURANT FACILITY (EXISTING AND TO REMAIN)

FLOOR AREA (SQ.FT.)	LOAD RATIO	OCCUPANTS
4,369	1 / 15	291
1,519	1 / 200	8
223	1 / 50	4
113	1 / 15	8
238	1 / 100	2
540	1 / 15	36
615	1 / 100	6
	4,369 1,519 223 113 238 540	4,369 1 / 15   1,519 1 / 200   223 1 / 50   113 1 / 15   238 1 / 100   540 1 / 15

NUMBER OF EXITS PROVIDED MAX EXIT DISTANCE IN PROJECT

NEW OUTDOOR DINING AREA (EGRESS PROVIDED INDEPENDENTLY) OUTDOOR DINING AREA (NEW) 1,290 86

NUMBER OF EXITS PROVIDED 2-TOTAL MAX EXIT DISTANCE IN PROJECT

## MISC. EGRESS PLAN NOTES

- EGRESS ILLUMINATION AND EXIT SIGNAGE LOCATIONS SUBJECTY TO REVIEW BY CITY BUILDING DIVISION AND FIRE DEPT. INSPECTORS (CBC 1008, 1013)
- EGRESS DOORS MUST BE READILY OPENABLE FROM EGRESS SIDE WITHOUT USE OF A KEY OR ANY SPECIAL KNOWLEDGE OR EFFORT. UNLATCHING ANY OR OR LEAF SHALL NOT REQUIRE MORE THAN ONE OPERATION. (CBC 1010.1.9)
- 3. MANUALLY OPERATED FLUSH BOLTS OR SURFACE BOLTS ARE NOT PERMITTED ON ANY
- 4. OCCUPANCY LOAD TO BE POSTED IN A CONSPICUOUS PLACE, NEAR THE MAIN EXIT ACCESS DOORWAY FROM THE ROOM OR SPACE.

## FIXTURE OCCUPANCY CALCS.

ROOM NAME	FLOOR AREA (SQ.FT.)	LOAD RATIO	OCCUPANTS
LOUNGE/ DINING AREAS (TOTAL)	4,369	1 / 30	146
KITCHEN AREAS (TOTAL)	1,519	1 / 50	30
BAR (NON-CUSTOMER AREA)	223	1 / 50	5
RECEPTION AREA	113	1 / 15	8
OFFICE 1	238	1 / 150	2
2ND FLOOR - PRIVATE DINING	540	1 / 30	18
2ND FLOOR - OFFICE 2	615	1 / 150	4
OUTDOOR DINING AREA (NEW)	1,290	1 / 30	43

TOTALFIXTURE OCCUPANCY LOAD

REQUIRED FIXTURE COUNTS (PER CPC 4-1)

WOMEN 4

**256 TOTAL** 128 MEN / 128 WOMEN

355 TOTAL OCCUPANTS

145'


2-TOTAL

BLDG. DEPT. PLN. CHK

DRAWN BY DATE 02-10-2023

> SCALE 3/16"=1'-0"

A2.0

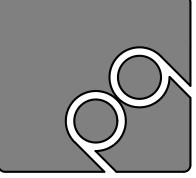

PQ DESIGN STUDIOINC

2425 LA FRANCE STREET SAN DIEGO, CALIFORNIA 92109 TELEPHONE: 1-858-527-0818

© 2021, PQ DESIGN STUDIO. ALL RIGHTS RESERVED. THESE PLANS MAY NOT BE REPRODUCED WITHOUT THE PRIOR WRITTEN CONSENT OF PQ DESIGN STUDIO INC. INTELLECTUAL PROPERTY RIGHTS FOR THIS DOCUMENT(S) ARE SOLELY MAINTAINED BY PQ DESIGN STUDIO INC.